
COVER SHEET THE REFUGE TRACT 3701, BLOCK 6, LOT 29&30 LAKE HAVASU CITY, ARIZONA 3698 N. WINIFRED WAY

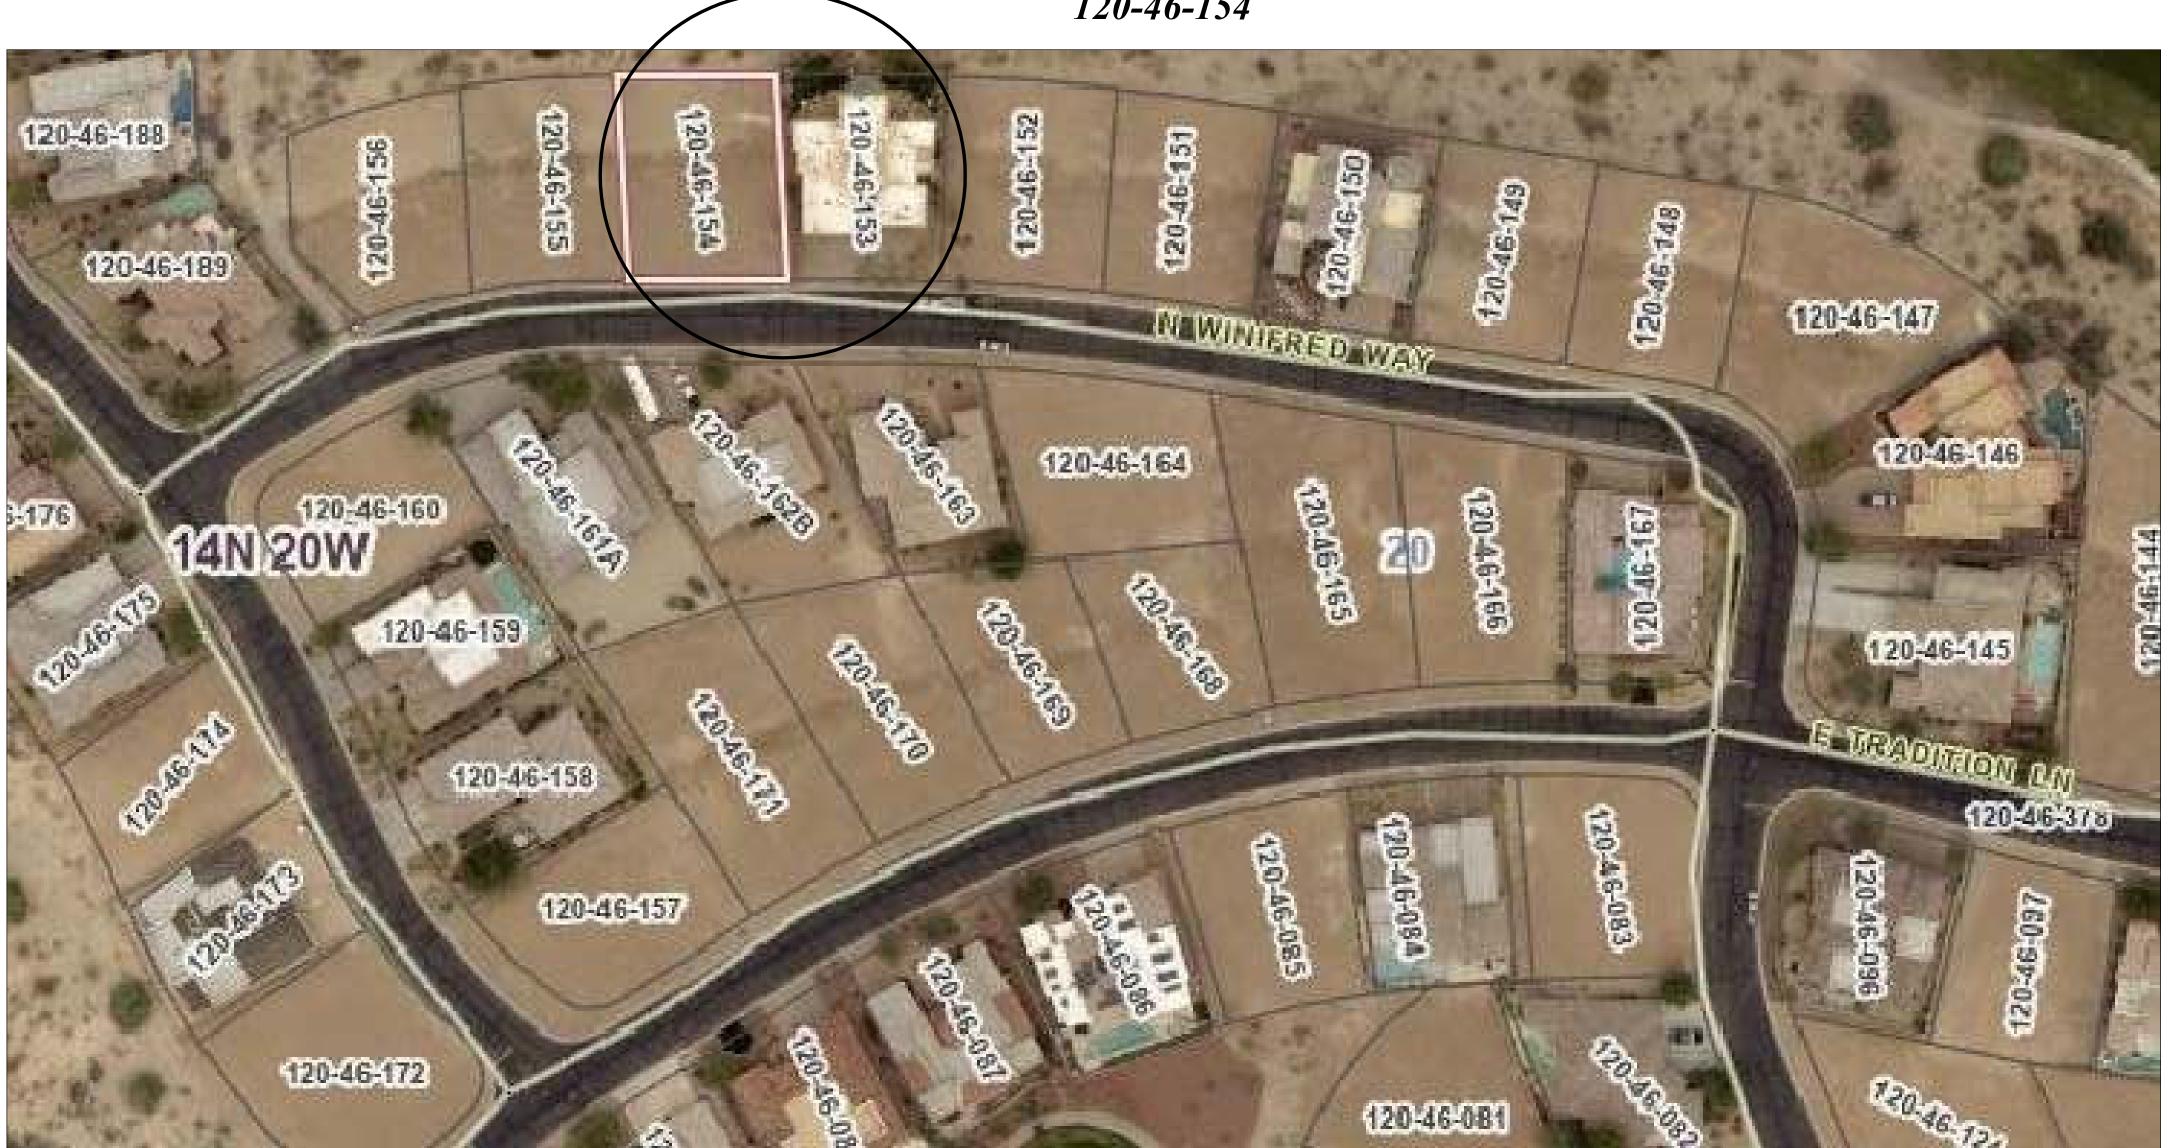

SHEET INDEX

SHEET CI - COVER SHEET
SHEET Ø1 - SITE PLAN
SHEET Ø2 - FOUNDATION PLAN
SHEET Ø3 - FLOOR PLAN
SHEET Ø4 - ROOF FRAMING PLAN
SHEET Ø5 - EXTERIOR ELEVATIONS
SHEET Ø6 - ELECTRICAL PLAN
SHEET Ø1 - SHEAR WALL PLAN
SHEET D1 - DETAIL SHEET

VICINIY MAP N.T.S.

GENERAL PLAN CODES

PLANS SHALL COMPLY WITH:

2018 (IRC) INTERNATIONAL RESIDENTIAL CODE

2018 (IMC) INTERNATIONAL MECHANICAL CODE

2018 (IPC) INTERNATIONAL PLUMBING CODE

2011 (NEC) NATIONAL ELECTRICAL CODE

2018 (IPMC) INTERNATIONAL PROPERTY MAINTENANCE CODE

2018 (IFC) INTERNATIONAL FIRE CODE

2018 (IFGC) INTERNATIONAL FUEL GAS CODE

SQUARE FOOTAGE'S

455 SQ. FT

3353 SQ. FT

173 SQ. F7

123 SQ, F

4104 SQ. FT.

LIVABLE

RV GARAGE

COVERED DECK

COVERED PATIO

TOTAL UNDER ROOF



COVER SHEET

DATE: 3-24-22

DRAWN: BLE

JOB #: 22070

FILE NAME:


ACADWG\CUSTOM\22070SP.DWG

REVISION:

REVISION:

SCALE: AS SHOWN
SHEET

C1

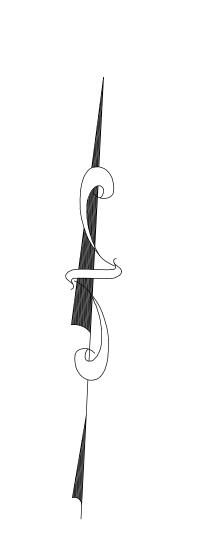

SITEPLAN THE REFUGE TRACT 3701, BLOCK 6, LOT 29&30 LAKE HAVASU CITY, ARIZONA 3698 N. WINIFRED WAY

GRAPHIC SCALE

(IN FEET) SCALE: 1" = 10' - 0"

GENERAL NOTES

B.S.L. INDICATES BUILDING SET-BACK LINE

PUE. INDICATES PUBLIC UTILITY EASEMENT

D.E. INDICATES DRAINAGE EASEMENT

INDICATES TEMPORARY BENCH MARK ASSUMED ELEVATION 100.00'

100,00 INDICATES FIELD MEASURED ELEVATION

ZONING 15 R-1

NOTE: ZONING AND BUILDING SET - BACK LINES SHOULD BE VERIFIED PER L.H.C. BUILDING DEPT BEFORE DESIGN AND/OR CONSTRUCTION.

GRADING NOTES

- 1. ALL SLOPES WILL BE GRADED TO 2 HORIZONTAL TO 1 VERTICAL SLOPE.
- 2. IF THE PROPER SLOPE CANNOT BE ACHIEVED, A MASONRY OR CONCRETE RETAINING WALL WILL BE PROVIDED. ROCK WALLS WILL NOT BE USED FOR RETENTION.

3. ALL SLOPES WILL HAVE A 6" BY 16" BERM AT THE TOP OF THE SLOPE.


4. ALL HOUSES WILL PROVIDE A SLOPE AWAY FROM THE HOUSE TO DIRECT RAINWATER AWAY FROM THE

- 5. ALL HOUSES WILL HAVE A THREE (3) FOOT WIDE AREA AROUND THE STRUCTURE WHICH CAN BE
- EASILY WALKED ON.

 6. DURING GRADING, DUST WILL BE CONTROLLED.
- 1, EXCAVATIONS OVER THREE (3) FEET WILL BE PRO-TECTED FROM PUBLIC ENCROCHMENT,
- 8. ALL VEGETATION AND DELETERIOUS MATERIALS WILL BE REMOVED BEFORE A PRE-GRADE INSPECTION IS DONE.
- 9. COMPACTION TESTS TO BE PERFORMED BY:

NOTE: FINISH FLOOR OF ADDITION TO MATCH FINISH FLOOR OF EXISTING HOUSE.

NOTE: ALL UTILITIES FOR ADDITION TO BE PULLED FROM EXISTING

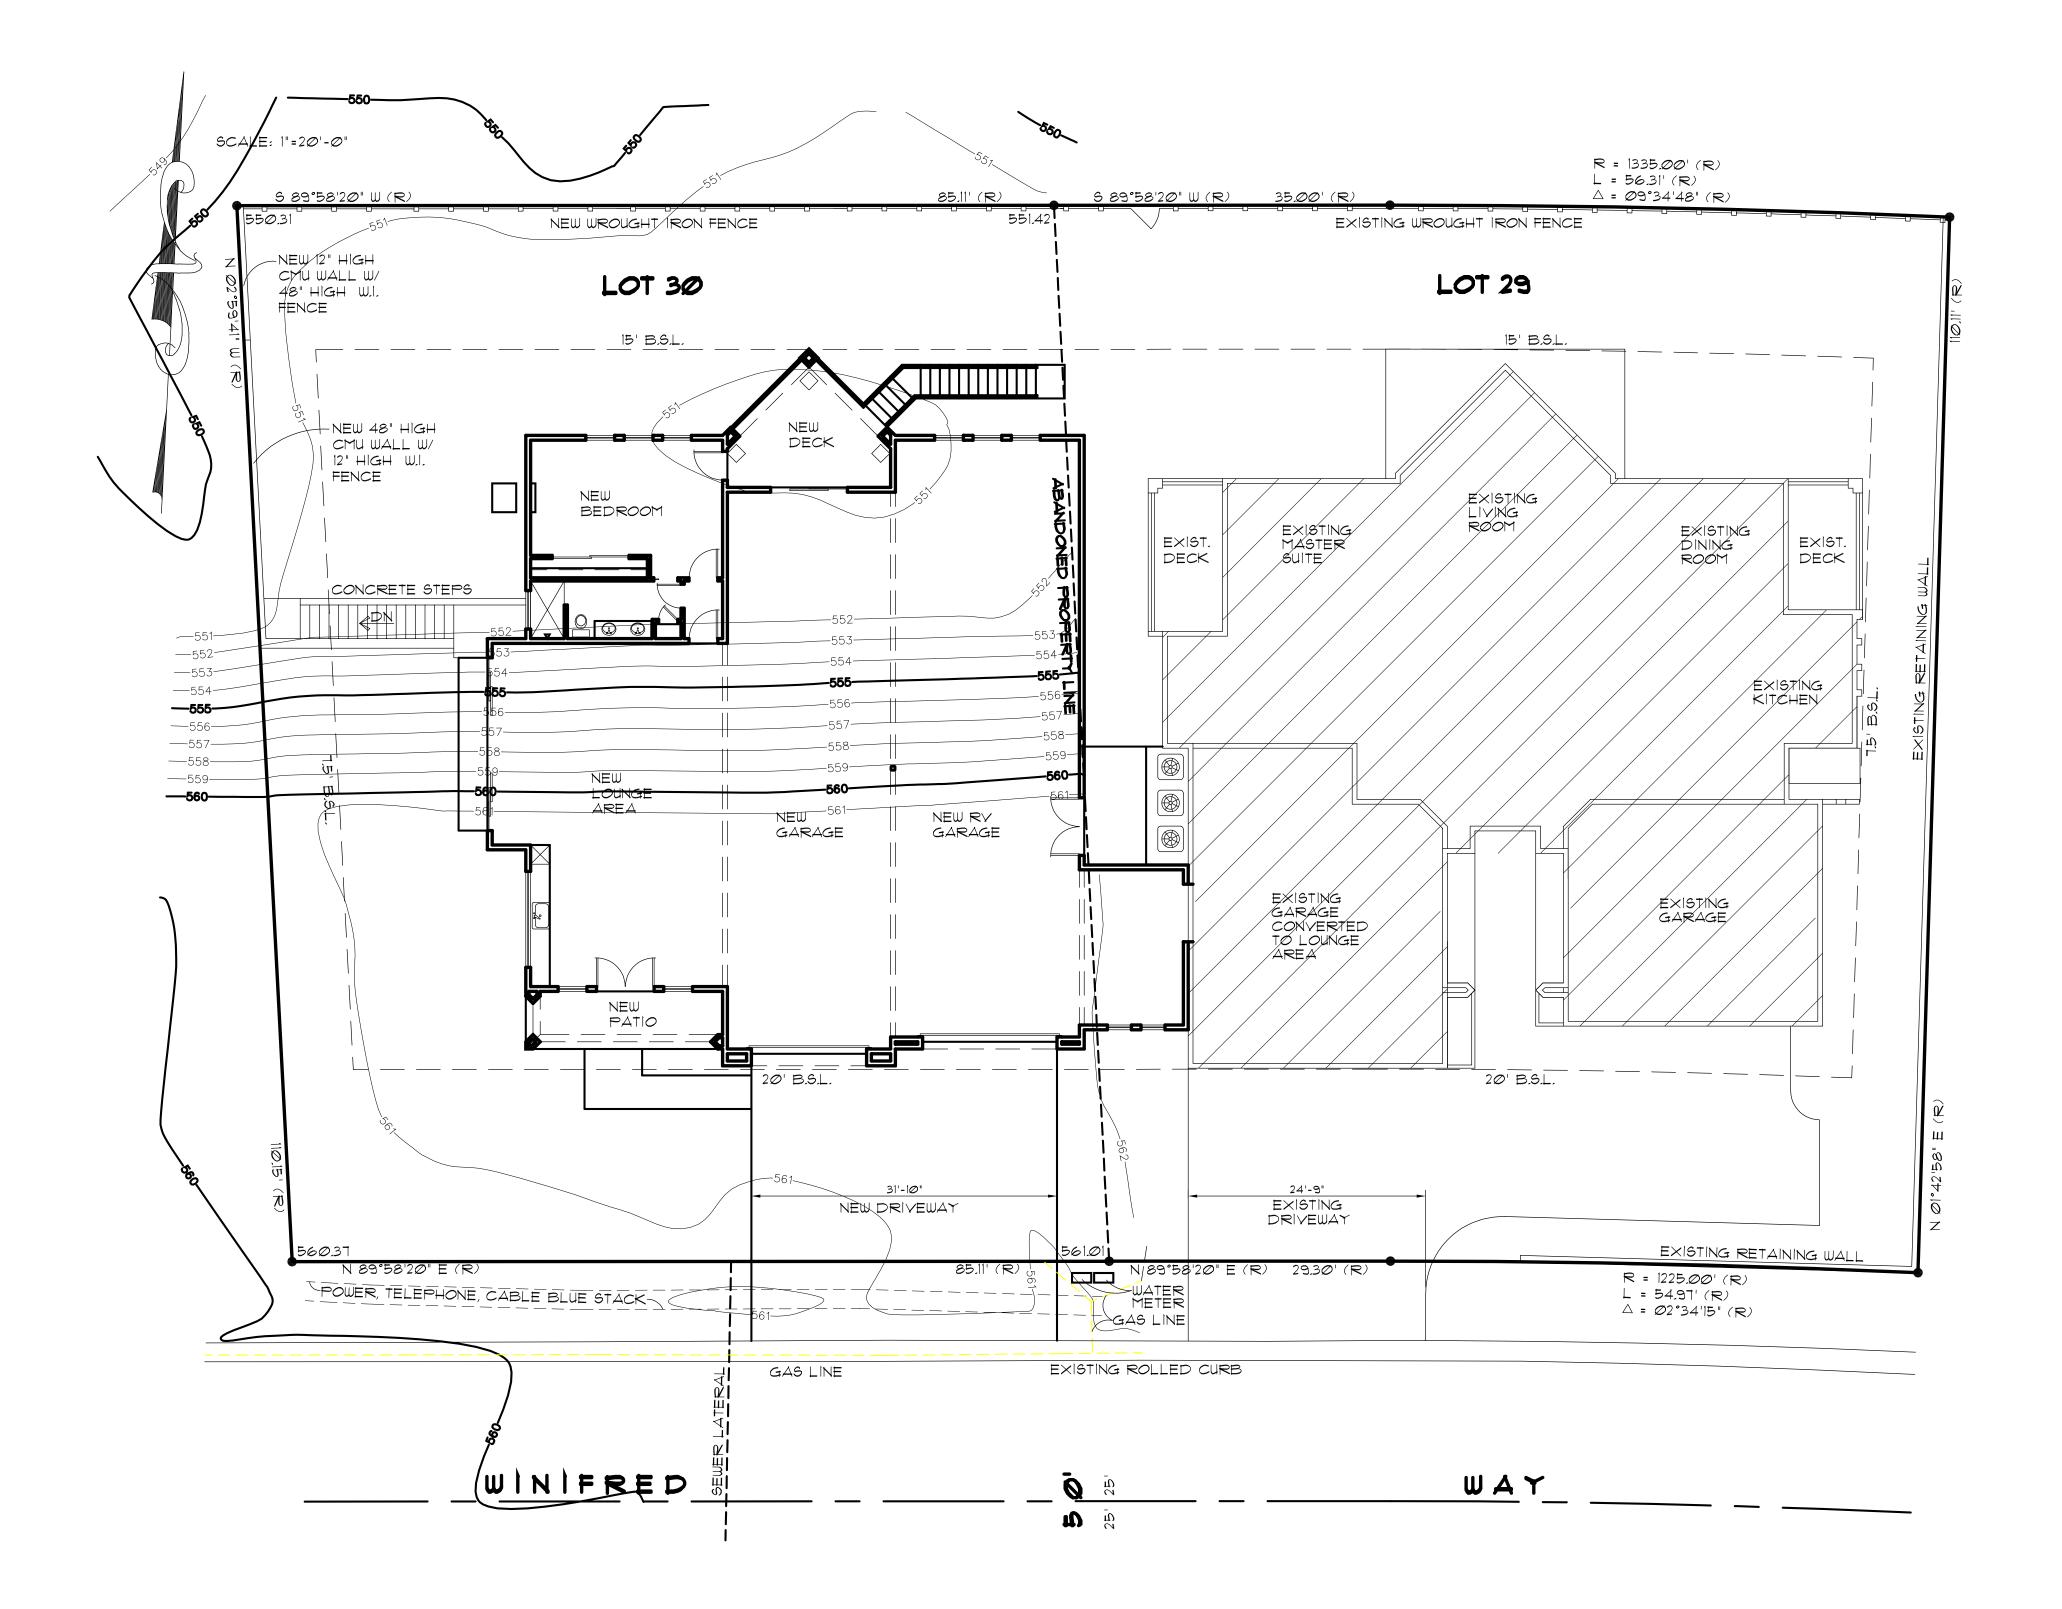

IMMY Shomof 505 N Beverly Drive Beverly Hills, CA. 90210 (310) 780, 7435

& Casita Addition Designe



DATE: 3-24-22

DRAWN: BLE

JOB # : 22070

FILE NAME:
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REVISION:


REVISION:



FOUNDATION PLAN DATE: 3-24-22 REVISION: 🛆

REVISION: 🛆 SCALE: AS SHOWN

EXPIRES: 9/30/23

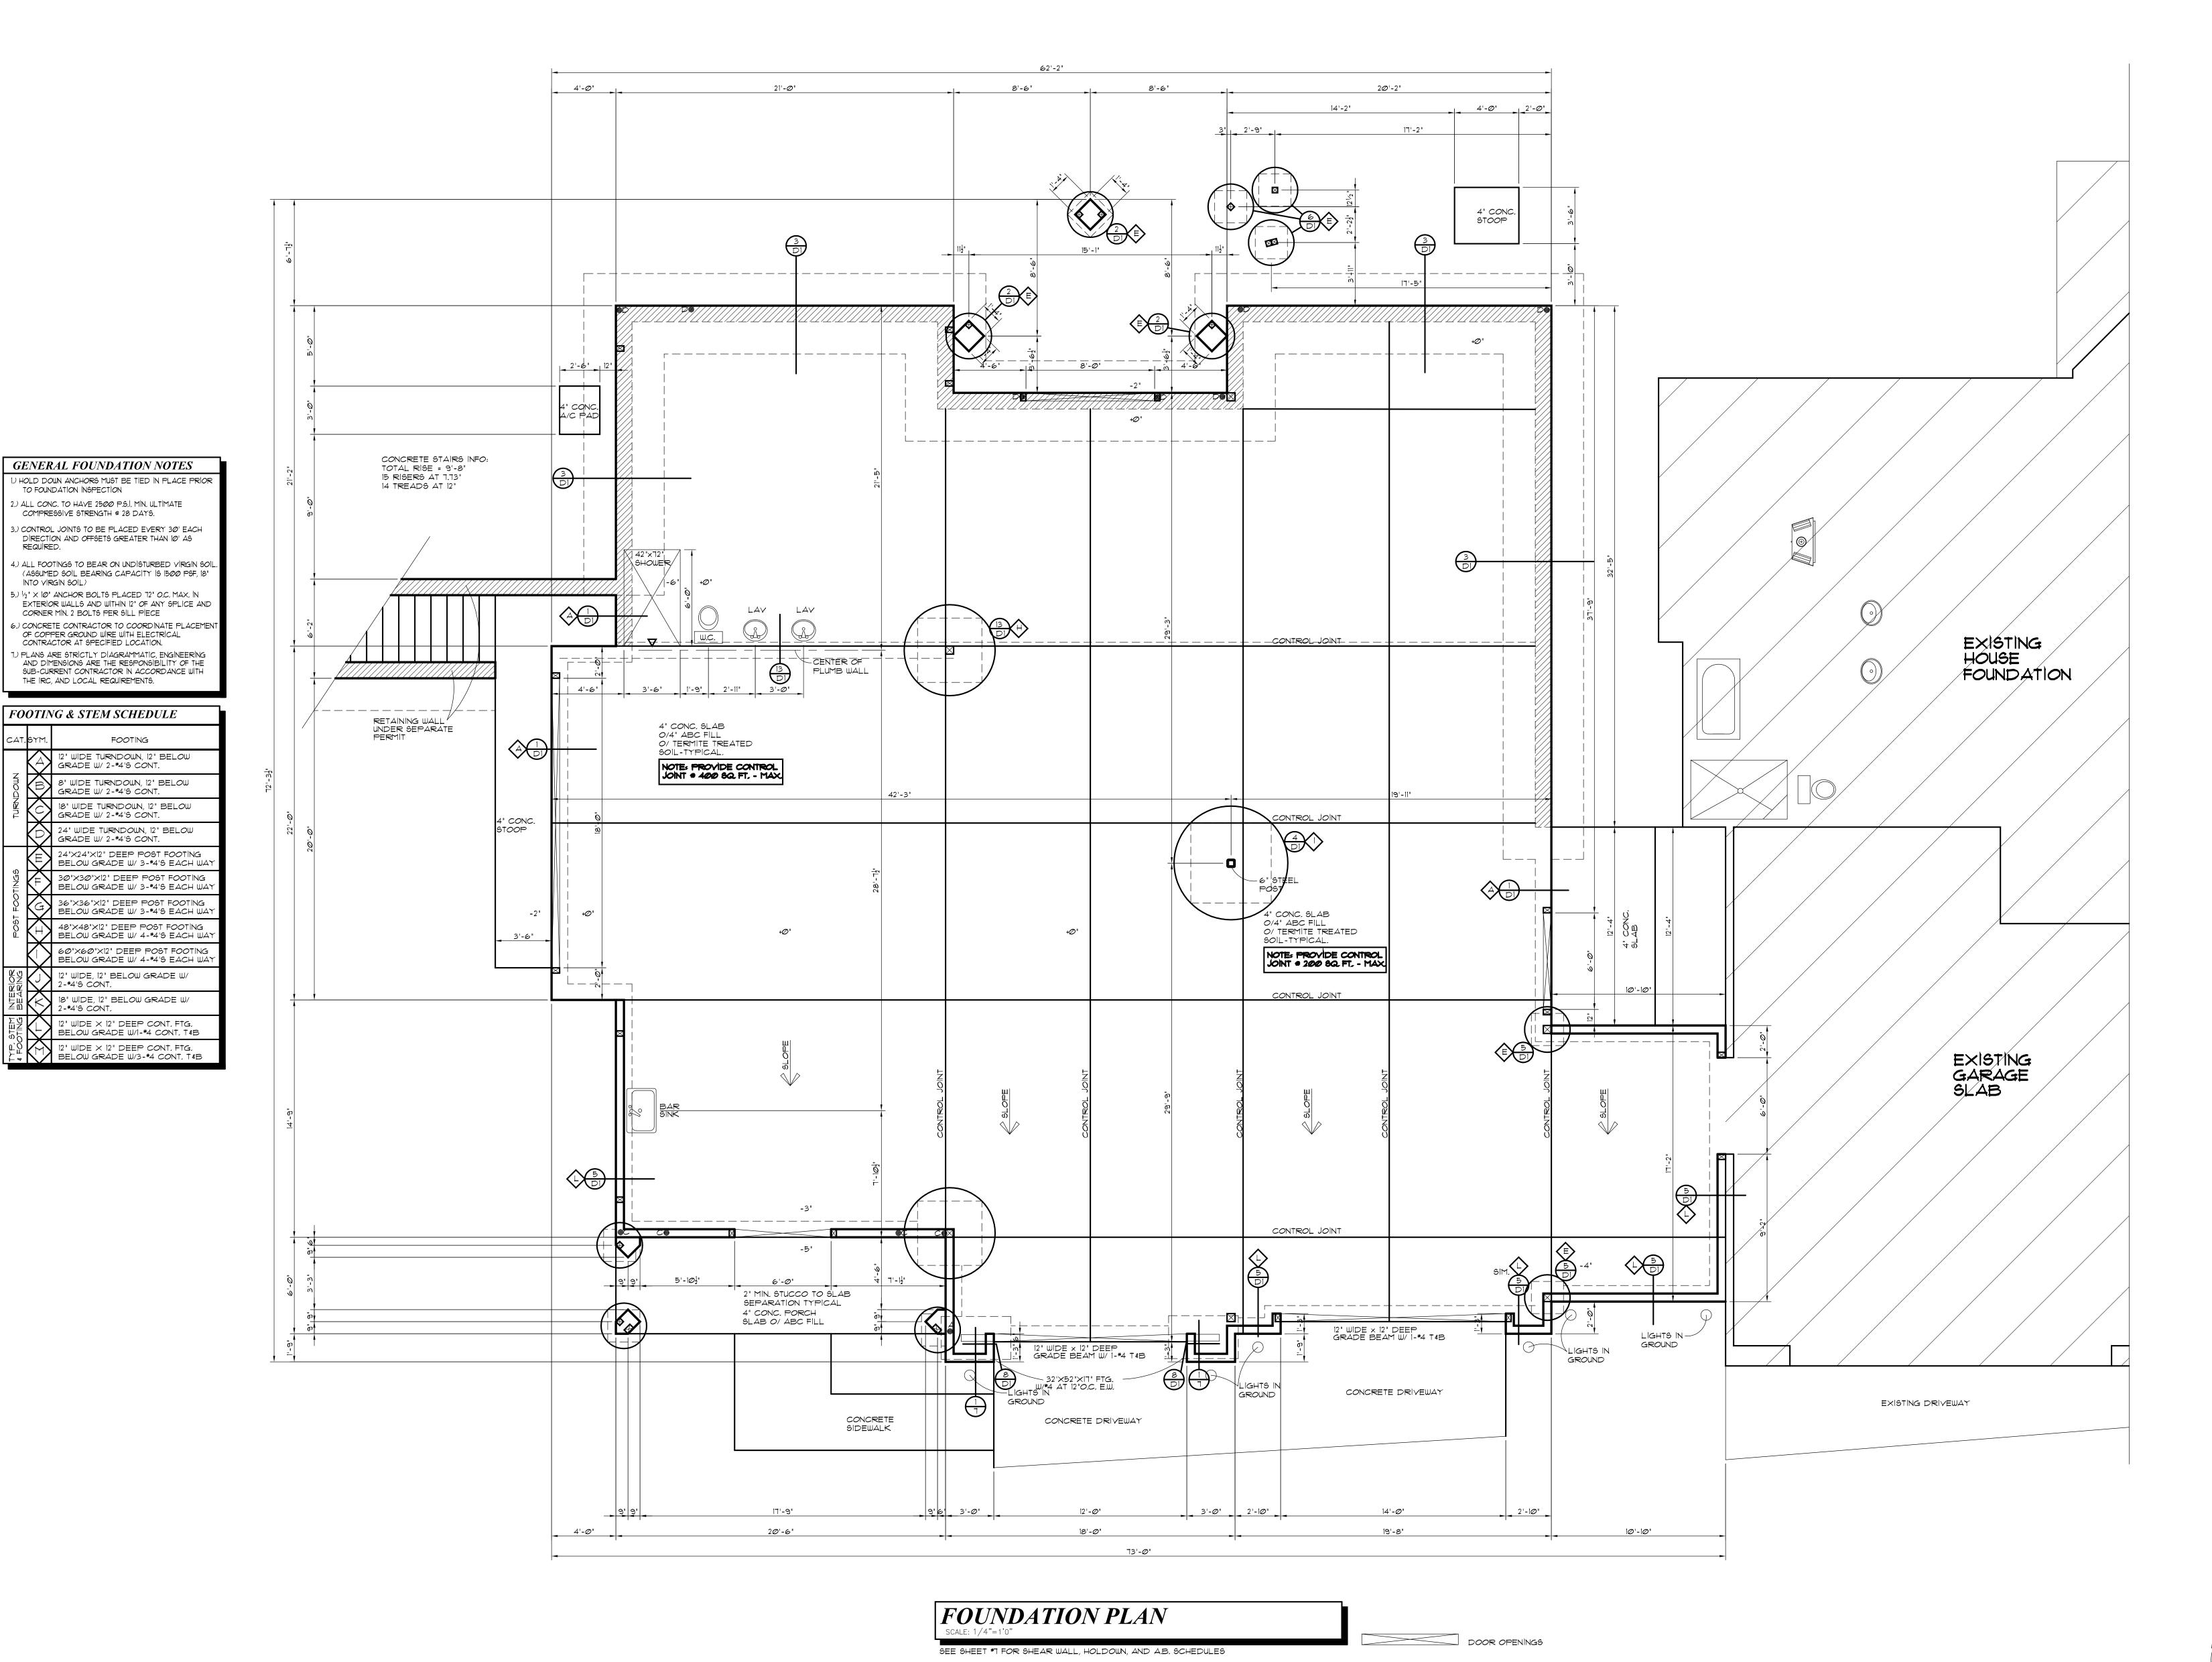

2.) ALL CONC. TO HAVE 2500 P.S.I. MIN. ULTIMATE COMPRESSIVE STRENGTH @ 28 DAYS.

CORNER MIN. 2 BOLTS PER SILL PIECE

CONTRACTOR AT SPECIFIED LOCATION.

THE IRC, AND LOCAL REQUIREMENTS.

FOOTING & STEM SCHEDULE

12" WIDE TURNDOWN, 12" BELOW GRADE W/ 2-#4'S CONT.

8" WIDE TURNDOWN, 12" BELOW GRADE W/ 2-#4'S CONT.

18" WIDE TURNDOWN, 12" BELOW GRADE W/ 2-#4'5 CONT.


24" WIDE TURNDOWN, 12" BELOW GRADE W/ 2-*4'S CONT.

 $\frac{0000}{0000}$ 12" WIDE, 12" BELOW GRADE W/ 2-*4'S CONT.

18" WIDE, 12" BELOW GRADE W/ 2-*4'S CONT.


OF COPPER GROUND WIRE WITH ELECTRICAL


INTO VIRGIN SOIL)

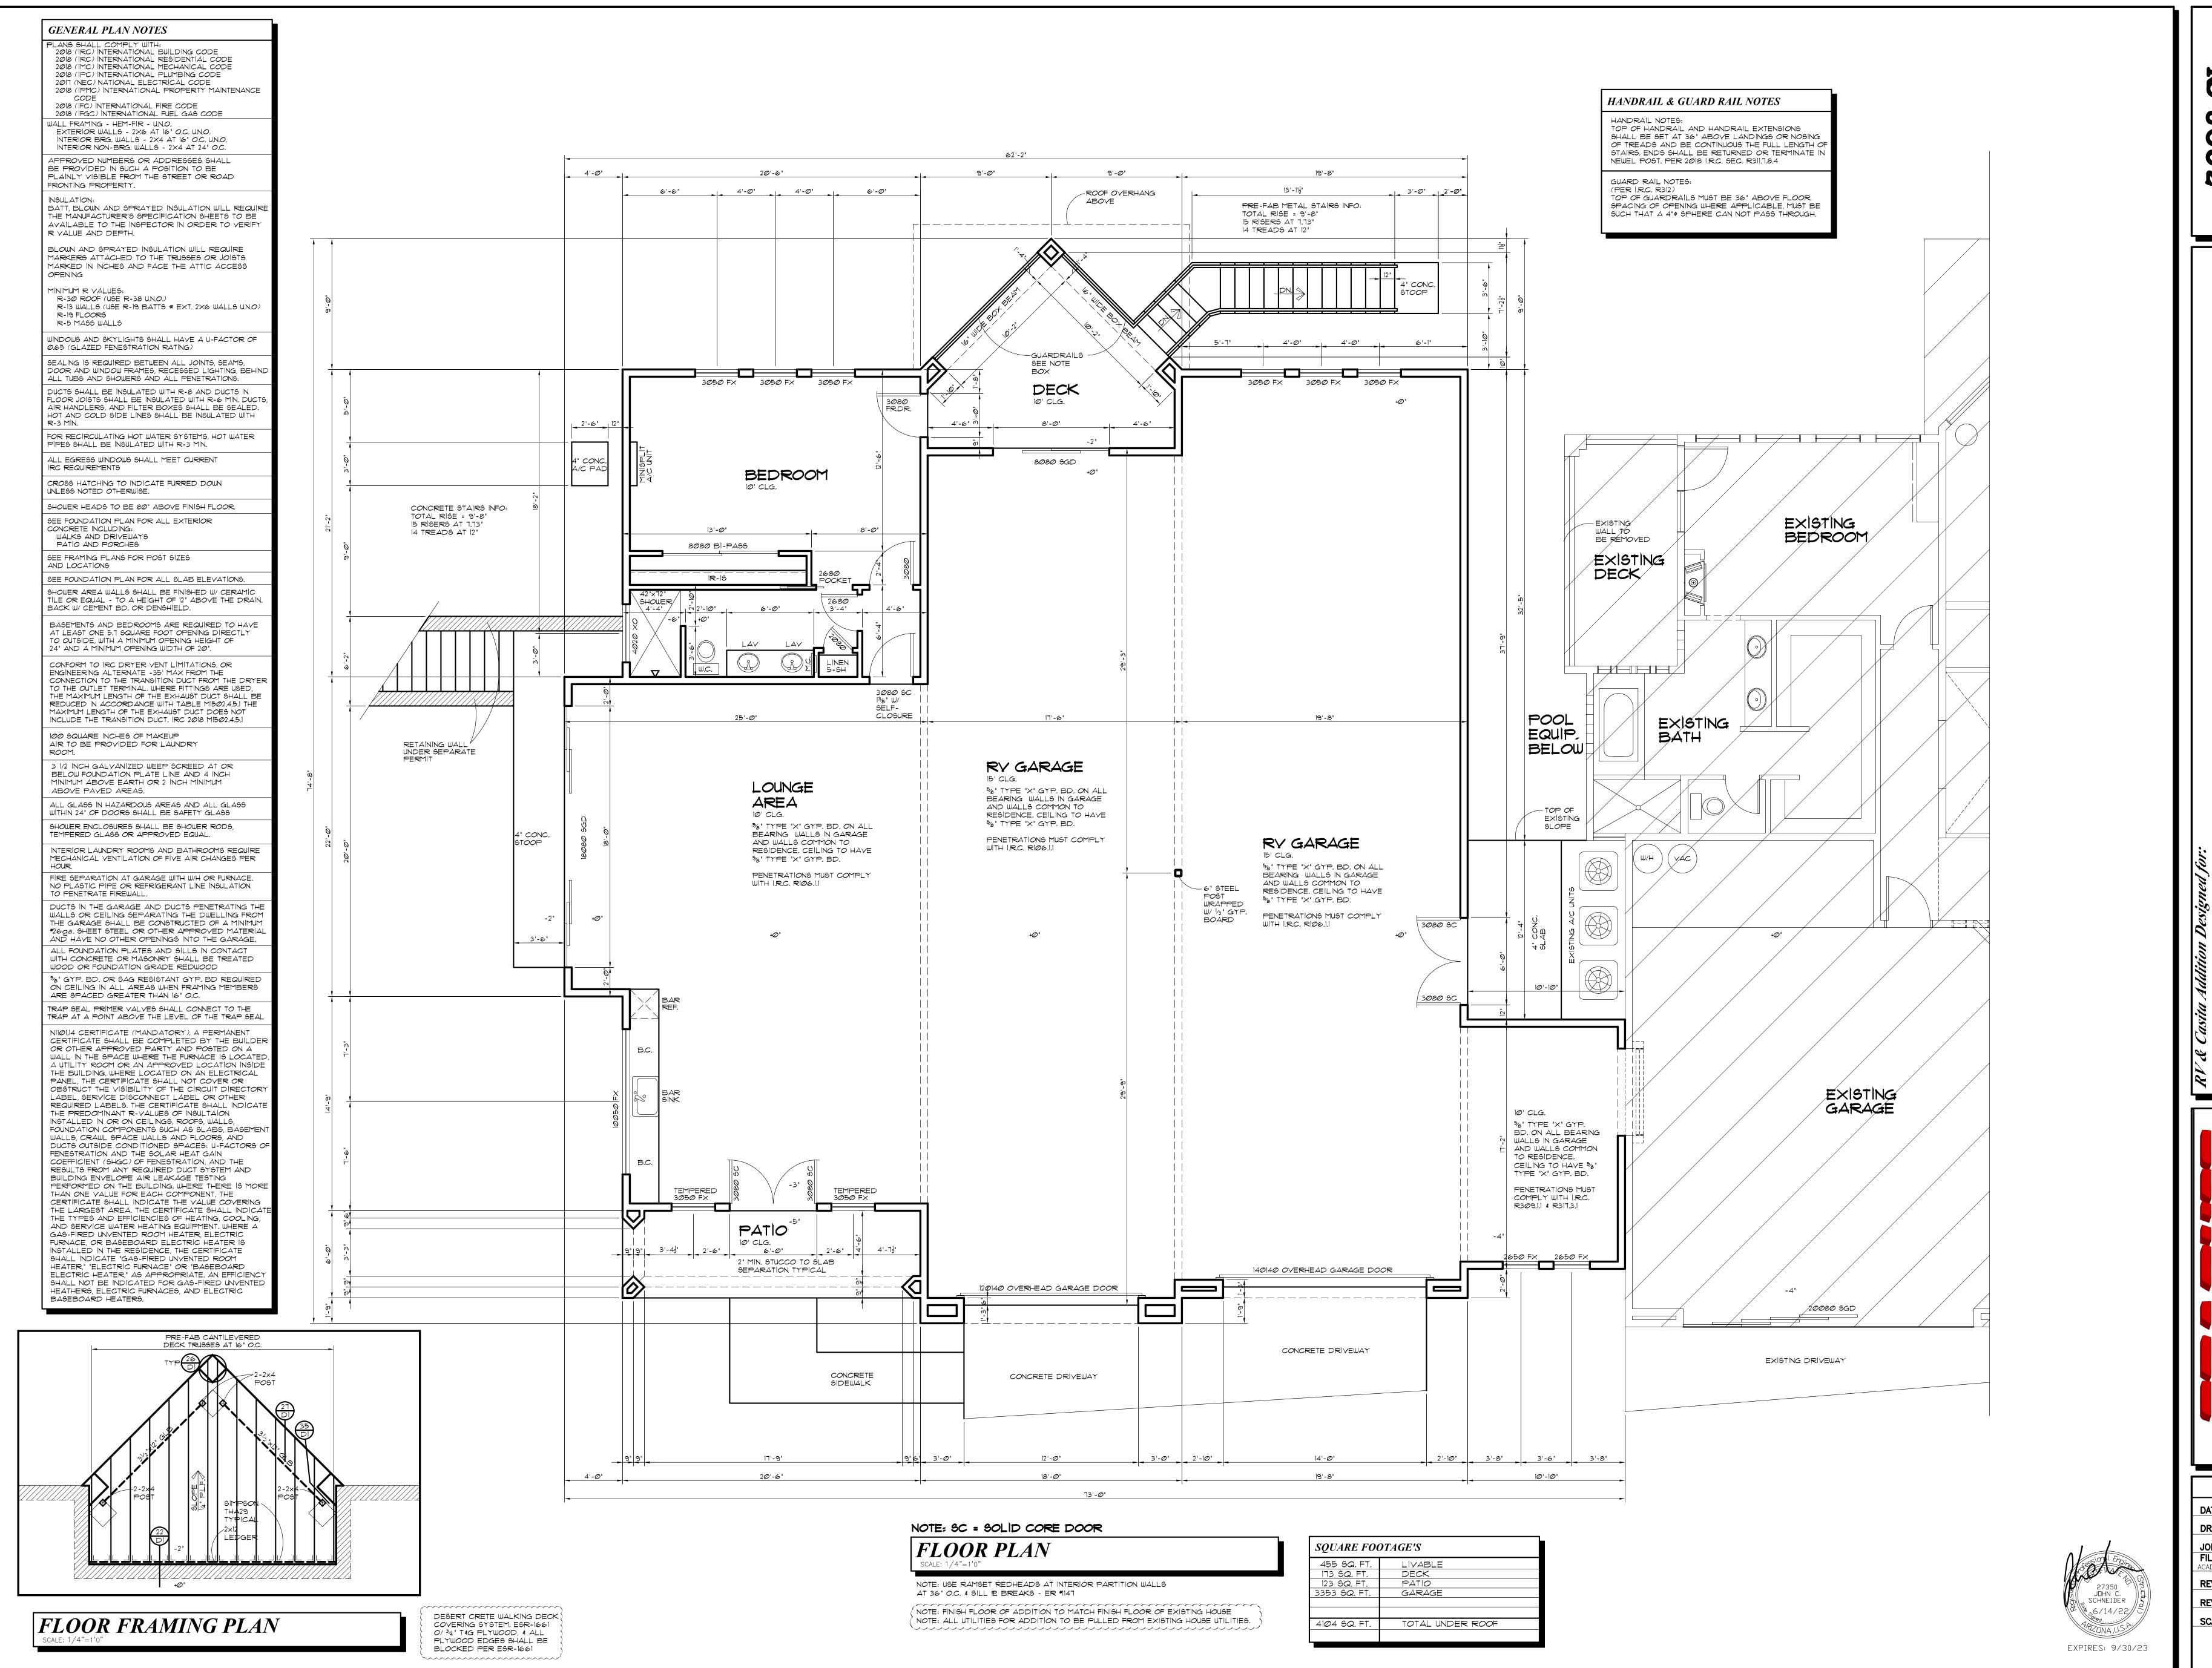

86

FLOOR PLAN DATE: 3-24-22 DRAWN: BRM/GMP/BLE FILE NAME: REVISION: 🛆 REVISION: 🛆 SCALE: AS SHOWN

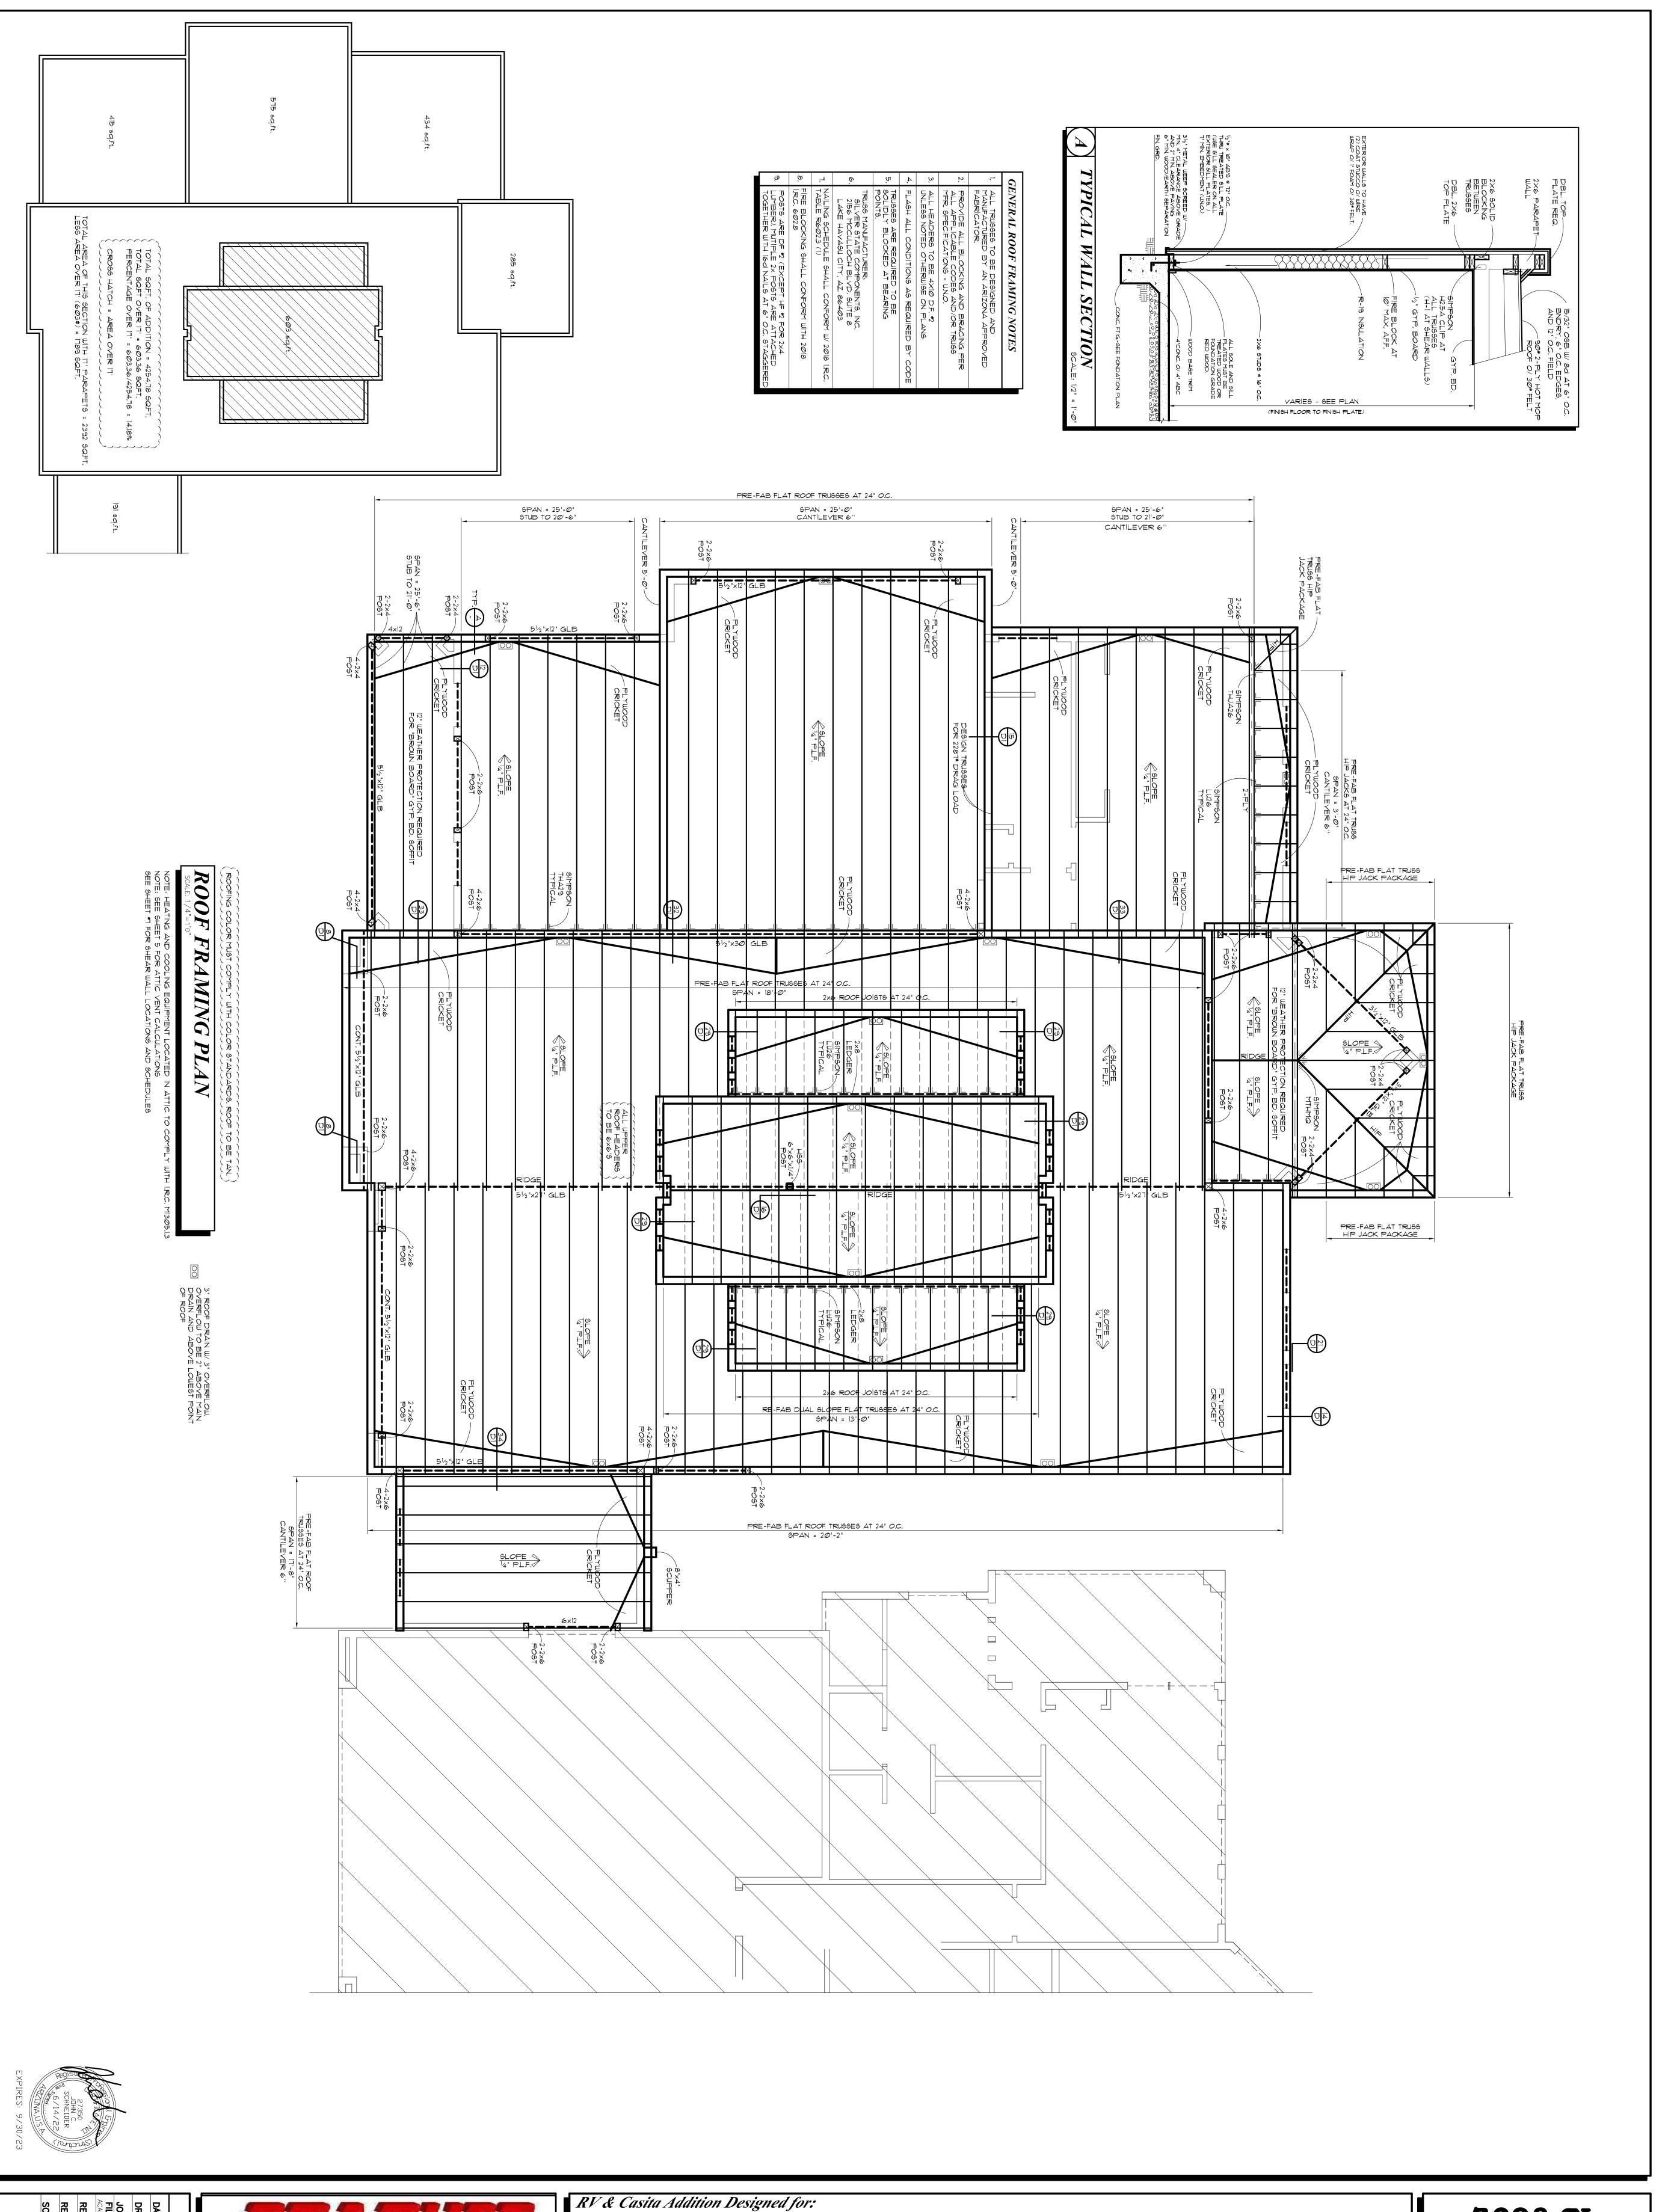

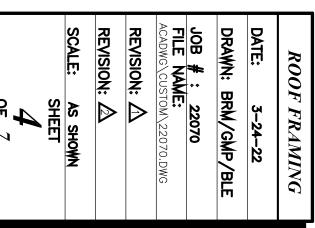



(310) 780-7435

.R 8698 May SeWay JOUIOUS (018)

SEP-1-082 (018)

SEP-1-082 (018)

RV & Casita Addition Designed for:



EXT. ELEVATIONS

DATE: 3-24-22

DRAWN: BRM/GMP/BLE

JOB #: 22070
FILE NAME:

ACADWG\CUSTOM\22070.DWG

REVISION: △

REVISION: △

SCALE: AS SHOWN

SHEET

SHEET

SHEET

SF 7

